

NOTE: This is a standard symbol list and not all items listed may be used.


Abbreviations

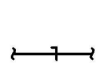
AFF	ABOVE FINISHED FLOOR
AD	ACCESS DOOR
A/C	AIR CONDITION(ED)
AHU	AIR HANDLING UNIT
BDD	BACKDRAFT DAMPER
BFF	BELOW FINISHED FLOOR
BHP	BRAKE HORSEPOWER
CL	CENTERLINE
COP	COEFFICIENT OF PERFORMANCE
CD	CONDENSATE DRAIN
CU	CONDENSING UNIT
CONT.	CONTINUATION
CFM	CUBIC FEET PER MINUTE
DB	DECIBEL
DP	DEW POINT, DIFFERENTIAL PRESSURE
DIA	DIAMETER
DX	DIRECT EXPANSION
D	DROP
DB	DRY BULB
EFF	EFFICIENT
ELECT	ELECTRICAL
EL	ELEVATION
EER	ENERGY EFFICIENCY RATING
EAT	ENTERING AIR TEMPERATURE
EXH	EXHAUST
EF	EXHAUST FAN
(E)	EXISTING
F	FAHRENHEIT
FC	FAN COIL
FT	FEET
FPM	FEET PER MINUTE
FPI	FINS PER INCH
FD	FIRE DAMPER
FLA	FULL LOAD AMPS
GAL	GALLONS
GPM	GALLONS PER MINUTE
HK	HEAT EXCHANGER
HTG	HEATING
HP	HORSEPOWER
IN	INCHES
KW	KILOWATT
LH	LATENT HEAT
LAT	LEAVING AIR TEMPERATURE
LWT	LEAVING WATER TEMPERATURE
MAX	MAXIMUM
MIN	MINIMUM
MA	MIXED AIR
NC	NOISE CRITERIA
N/A	NOT APPLICABLE
NIC	NOT IN CONTRACT
NTS	NOT TO SCALE
NO.	NUMBER
OC	ON CENTER
OBD	OPPOSED BLADE DAMPER
OA	OUTSIDE AIR
OSA	OUTSIDE AIR
PH	PHASE
LBS.	POUNDS
PSI	POUNDS PER SQUARE INCH
PD	PRESSURE DROP
QTY	QUANTITY
REF	REFRIGERANT
RL	REFRIGERANT LIQUID
RS	REFRIGERANT SUCTION
RH	RELATIVE HUMIDITY
RET	RETURN
RA	RETURN AIR
RPM	REVOLUTIONS PER MINUTE
R	RISE
SEER	SEASONAL ENERGY EFFICIENCY RATING
SH	SENSIBLE HEAT
SF	SQUARE FEET
SP	STATIC PRESSURE
SA	SUPPLY AIR
T, TEMP	TEMPERATURE
MBH	THOUSAND BTU'S PER HOUR
TH	TOTAL HEAT
TP	TOTAL PRESSURE
VEL	VELOCITY
V	VOLT
VD	VOLUME DAMPER (HAND OPERATOR)
WC	WATER COLUMN
W	WATT
WB	WET BULB
W	WITH
W/O	WITHOUT

Control Symbols

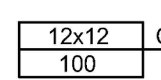
 AC-1 ROOM THERMOSTAT


Dampers

 FIRE DAMPER

 VOLUME DAMPER

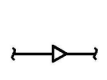
Diffusers and Grilles

 12x12 CD-1 DIFFUSER OR GRILLE IDENTIFICATION

 EXHAUST AIR

 SUPPLY AIR

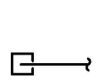
Ductwork Fittings

 CONCENTRIC SQUARE TO ROUND

 CONCENTRIC TRANSITION, RECTANGULAR OR ROUND

 ECCENTRIC TRANSITION, RECTANGULAR OR ROUND

 FLEXIBLE CONNECTION

 RECTANGULAR DUCT DROP

 RECTANGULAR DUCT RISER

 RECTANGULAR MAIN WITH RECTANGULAR BRANCH

 RECTANGULAR MAIN WITH ROUND BRANCH

 RECTANGULAR OFFSET LESS THAN 15% $\theta$

 RECTANGULAR OFFSET MORE THAN 15% $\theta$

 ROUND DUCT DROP

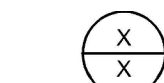
 ROUND DUCT RISER

 ROUND DUCT WITH ROUND BRANCH

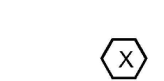
 MITERED ELBOW WITH TURNING VANES

 RADIUSED ELBOW

General


 DETAIL NUMBER AND SHEET LOCATION

 EQUIPMENT IDENTIFICATION

 KEYED NOTE

 LIMIT OF DEMOLITION

 POINT OF CONNECTION

 SECTION NUMBER AND SHEET LOCATION

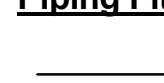
 EXISTING WORK

 NEW WORK

 RECTANGULAR DUCT SIZING

 ROUND DUCT SIZING


Piping Fittings, Appurtenances and Equipment

 CONTINUATION

 FLEXIBLE CONNECTION

 FLOW DIRECTION

 PIPE DROP

 PIPE RISE

Piping Systems

 RL REFRIGERANT LIQUID

 RS REFRIGERANT SUCTION

Approved with Exceptions  
Checking is for general conformance with the design concept of the project and general compliance with the information given in the contract documents. Any corrections or comment are subject to the requirements of the plans and specifications. Contractor is responsible for dimensions which shall be confirmed and correlated at the job site, fabrication processes and techniques of construction, coordination of the work with that of all the trades and satisfactory performance of the work and all code requirements. All sections shall conform with the Uniform Mechanical Code and the Uniform Plumbing Code, any other applicable codes and the Amendments to the Mechanical and Plumbing Codes

TAMARA KUYKENDALL

GENERAL MECHANICAL NOTES

- COORDINATE INSTALLATION OF DUCTWORK, PIPING, FIXTURES, EQUIPMENT, ETC. WITH ARCHITECTURAL, STRUCTURAL, MECHANICAL, ELECTRICAL AND FIRE PROTECTION SYSTEMS PRIOR TO INSTALLATION.
- PROVIDE CEILING ACCESS PANELS FOR ALL DUCT DAMPERS OR CONCEALED VOLUME DAMPER REGULATORS LOCATED ABOVE INACCESSIBLE CEILING SYSTEMS. MAINTAIN FIRE RATINGS WHERE REQUIRED.
- INSTALL THERMOSTATS AT 4'-0" A.F.F. PER ADA REQUIREMENTS UNLESS OTHERWISE NOTED ON DRAWINGS. 4'-0" DIMENSION TO BE TO THE TOP OF THE THERMOSTAT.
- COORDINATE EXACT LOCATION OF ALL CEILING GRILLES AND DIFFUSERS WITH ARCHITECTURAL REFLECTED CEILING PLAN, ARCHITECTURAL INTERIOR ELEVATIONS, LIGHTING, AND STRUCTURAL CONDITIONS. ARCHITECTURAL PLANS TO PROVIDE FINAL GRILLE AND DIFFUSER LOCATIONS IN THE EVENT OF A CONFLICT.
- ALL WORK PERFORMED AND MATERIAL SUPPLIED SHALL CONFORM TO ALL STATE AND LOCAL CODES AND ALL OTHER APPLICABLE LAWS AND STATE REGULATIONS INCLUDING APPLICABLE SEISMIC ZONE REQUIREMENTS.
- MAINTAIN ALL OUTSIDE AIR INTAKE OPENINGS MINIMUM 10'-0" FROM ALL MECHANICAL VENTS, PLUMBING VENTS AND EXHAUST FANS.
- CONTRACTOR TO TEMPORARILY INSTALL 2" THICK 60% EFFICIENT FILTERS AT ALL RETURN AIR GRILLE LOCATIONS. FILTERS TO BE REMOVED AT CONCLUSION OF CONSTRUCTION.
- PAINT ALL DIFFUSERS, REGISTERS AND GRILLES PER ARCHITECTURAL INSTRUCTIONS. ANY GRILLES INSTALLED IN GYPSUM BOARD WALLS AND CEILINGS ARE TO BE FURNISHED WITH FACTORY MILL OR PRIMER FINISH, READY FOR PAINTING IN THE FIELD.
- DIFFUSER/GRILLE RUNOUTS ARE SAME SIZE AS DIFFUSER/GRILLE NECK SIZE UNLESS OTHERWISE NOTED ON PLANS.
- MAINTAIN REQUIRED CLEARANCES TO COMBUSTIBLE CONSTRUCTION AS SPECIFIED IN THE LISTING AND MANUFACTURER'S INSTRUCTIONS.
- EQUIPMENT TO BE ACCESSIBLE FOR INSPECTION, SERVICE, REPAIR AND REPLACEMENT WITHOUT REMOVING PERMANENT CONSTRUCTION, OTHER EQUIPMENT, VENTING SYSTEMS, PIPING, OR DUCTS CONNECTED TO THE EQUIPMENT BEING SERVICED.
- MAINTAIN MINIMUM DISTANCE OF 3'-0" BETWEEN ALL EXHAUST OUTLETS AND DOORS/OPERABLE WINDOWS.
- PROVIDE ONE BALANCING DAMPER FOR EACH AIR INLET/OUTLET SHOWN ON PLAN. WHERE DAMPER IS LOCATED ABOVE A HARD LID CEILING, PROVIDE REMOTE CABLE CONTROL FOR DAMPER.
- FOR ALL DUCT CONNECTIONS TO MECHANICAL EQUIPMENT, PROVIDE TRANSITION FROM DUCT SIZE SHOWN TO EQUIPMENT CONNECTION SIZE.
- ADJUST THROW OF ALL AIR DEVICES TO NOT INTERFERE WITH LIGHTING.
- INSTALL ALL EQUIPMENT SUCH THAT MANUFACTURER RECOMMENDED CLEARANCES ARE MAINTAINED.
- DETAILS APPLY WHETHER REFERENCED ON THE DRAWINGS OR NOT.
- INSTALL 1.5X RADIUS ELBOWS WHERE SPACE ALLOWS. OTHERWISE INSTALL MITERED ELBOWS WITH TURNING VANES CONSISTENT WITH SPECIFICATIONS.
- DUCTS, PIPING, AND EQUIPMENT TO BE INSTALLED AS HIGH AS POSSIBLE IN SPACES UNLESS OTHERWISE NOTED.
- COORDINATE WITH STRUCTURAL DRAWINGS FOR ALL SLAB AND WALL PENETRATIONS.
- SUPPORT EQUIPMENT, DUCTS, PIPING AS SPECIFIED AND AS SHOWN IN DETAILS. ENSURE EQUIPMENT WILL OPERATE WITHOUT OBJECTIONABLE VIBRATION AND NOISE.
- WHERE THE INSIDE OF DUCTS ARE VISIBLE FROM GRILLES OR DIFFUSERS, PAINT VISIBLE PORTION OF INSIDE OF DUCT FLAT BLACK.
- PENETRATIONS THRU RATED ASSEMBLIES TO BE APPROPRIATELY SEALED.



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SHEET TITLE

SYMBOL LIST AND  
GENERAL NOTES -  
MECHANICAL

REVISIONS


DRAWN BY

PHH

CHECKED BY

JMM

JOB NO.

2022-1372

DATE

03/31/2023

SHEET NUMBER

M0.1

SHEET INDEX

M0.1	SYMBOL LIST AND GENERAL NOTES - MECHANICAL
M0.2	SCHEDULES - MECHANICAL
M1.0	FIRST FLOOR PLAN - MECHANICAL
M1.1	SECOND FLOOR PLAN - MECHANICAL
M1.2	ROOF PLAN - MECHANICAL
M4.0	ENLARGED UNIT PLANS - MECHANICAL
M4.1	ENLARGED ACCESSIBLE UNIT PLANS - MECHANICAL
M7.1	DETAILS - MECHANICAL



## PACKAGED ROOFTOP AIR HANDLER UNIT SCHEDULE

## OUTSIDE AIR VENTILATION SCHEDULE - COMMON AREAS

## CONDENSING UNIT SCHEDULE

## FAN COIL SCHEDULE

## PACKAGED TERMINAL HEAT PUMP (PTHP) UNIT SCHEDULE

## OUTSIDE AIR VENTILATION SCHEDULE - APARTMENTS

## EXHAUST VENTILATION SCHEDULE

## DIFFUSER, REGISTER AND GRILLE SCHEDULE

## LOUVER SCHEDULE

FIRE DAMPER AND F/S DAMPER DETAILS  
MUST BE SUPPLIED AT JOBSITE PRIOR TO  
INSTALL, AND MUST BE SUBMITTED WITH AS  
BUILTS TO OWNER



A. VERIFY LOCATIONS, DIMENSIONS, ELEVATIONS, ETC. OF EXISTING CONDITIONS AND UTILITIES. CONDITIONS SHOWN ON THE PLANS RELATIVE TO THE WORK TO BE PERFORMED ARE BASED ON THE BEST INFORMATION AVAILABLE BUT ARE SUBJECT TO VERIFICATION. CORRECT DEFICIENCIES CAUSED BY FAILURE TO PERFORM SUCH VERIFICATIONS AT NO EXPENSE TO OWNER. IMMEDIATELY NOTIFY ARCHITECT OF CONDITION IN CONFLICT WITH THE PLANS.



ANDREW W. FRICHTL  
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16110  
PROFESSIONAL ENGINEER

1. PROVIDE PTHP-01 FOR NORTH FACING PERIMETER APARTMENTS. REFER TO DETAIL 1/M7.1.
2. PROVIDE PTHP-02 FOR SOUTH FACING PERIMETER APARTMENTS. REFER TO DETAIL 1/M7.1.
3. PROVIDE PTHP-03 FOR WEST FACING PERIMETER APARTMENTS. REFER TO DETAIL 1/M7.1.
4. INSTALL BOTTOM OF DUCTWORK ABOVE TOP OF WINDOW GLAZING SO DUCT IS NOT VISIBLE FROM INSIDE OF UNIT.
5. PROVIDE 6 NEW DRYER EXHAUST CONNECTIONS. REFER TO DETAIL M7.1. PROVIDE MAKE UP AIR THROUGH TRANSFER GRILLE FROM CORRIDOR. PROVIDE EXHAUST AIR LOUVER AND PLENUM. ROUTE ALL DRYER EXHAUST FROM DRYER, UP THROUGH WALL TO ABOVE CEILING SPACE, AND OVER TO EXHAUST AIR PLENUM. TERMINATE AT PLENUM WITH BACKDRAFT DAMPER.
6. CONSTRUCT DRYER EXHAUST DUCT WITH ALUMINUM SHEET METAL, MINIMUM 24 GAUGE. SUBSTANTIALLY AIRTIGHT DUCT EXCEPT FOR OPENING REQUIRE FOR OPERATION AND MAINTENANCE. DUCT TO HAVE SMOOTH INTERIOR SURFACE. DO NOT ASSEMBLY WITH SHEET METAL SCREENS, SCREWS, OR OTHER DEVICES THAT EXTEND INTO THE AIRSTREAM.
7. PROVIDE 2" DEEP PLENUM ON BACK OF LOUVER. PROVIDE CONICAL CONNECTIONS FROM DRYER EXHAUST DUCT TO LOUVER. ALIGN LOUVER, CENTERLINE TO CENTERLINE. ABOVE DOOR BELOW. PROVIDE HANGERS ON LOUVER FOR LIGHT REMOVAL. NO SCREENS ARE PERMITTED.
8. OFFSET DUCT DOWN, BELOW LOWER LEVEL CEILING, UNDER SECOND FLOOR APARTMENTS. AFFIX DUCT TO WALL.



ST FLOOR PLAN -  
MECHANICAL


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# M1.0

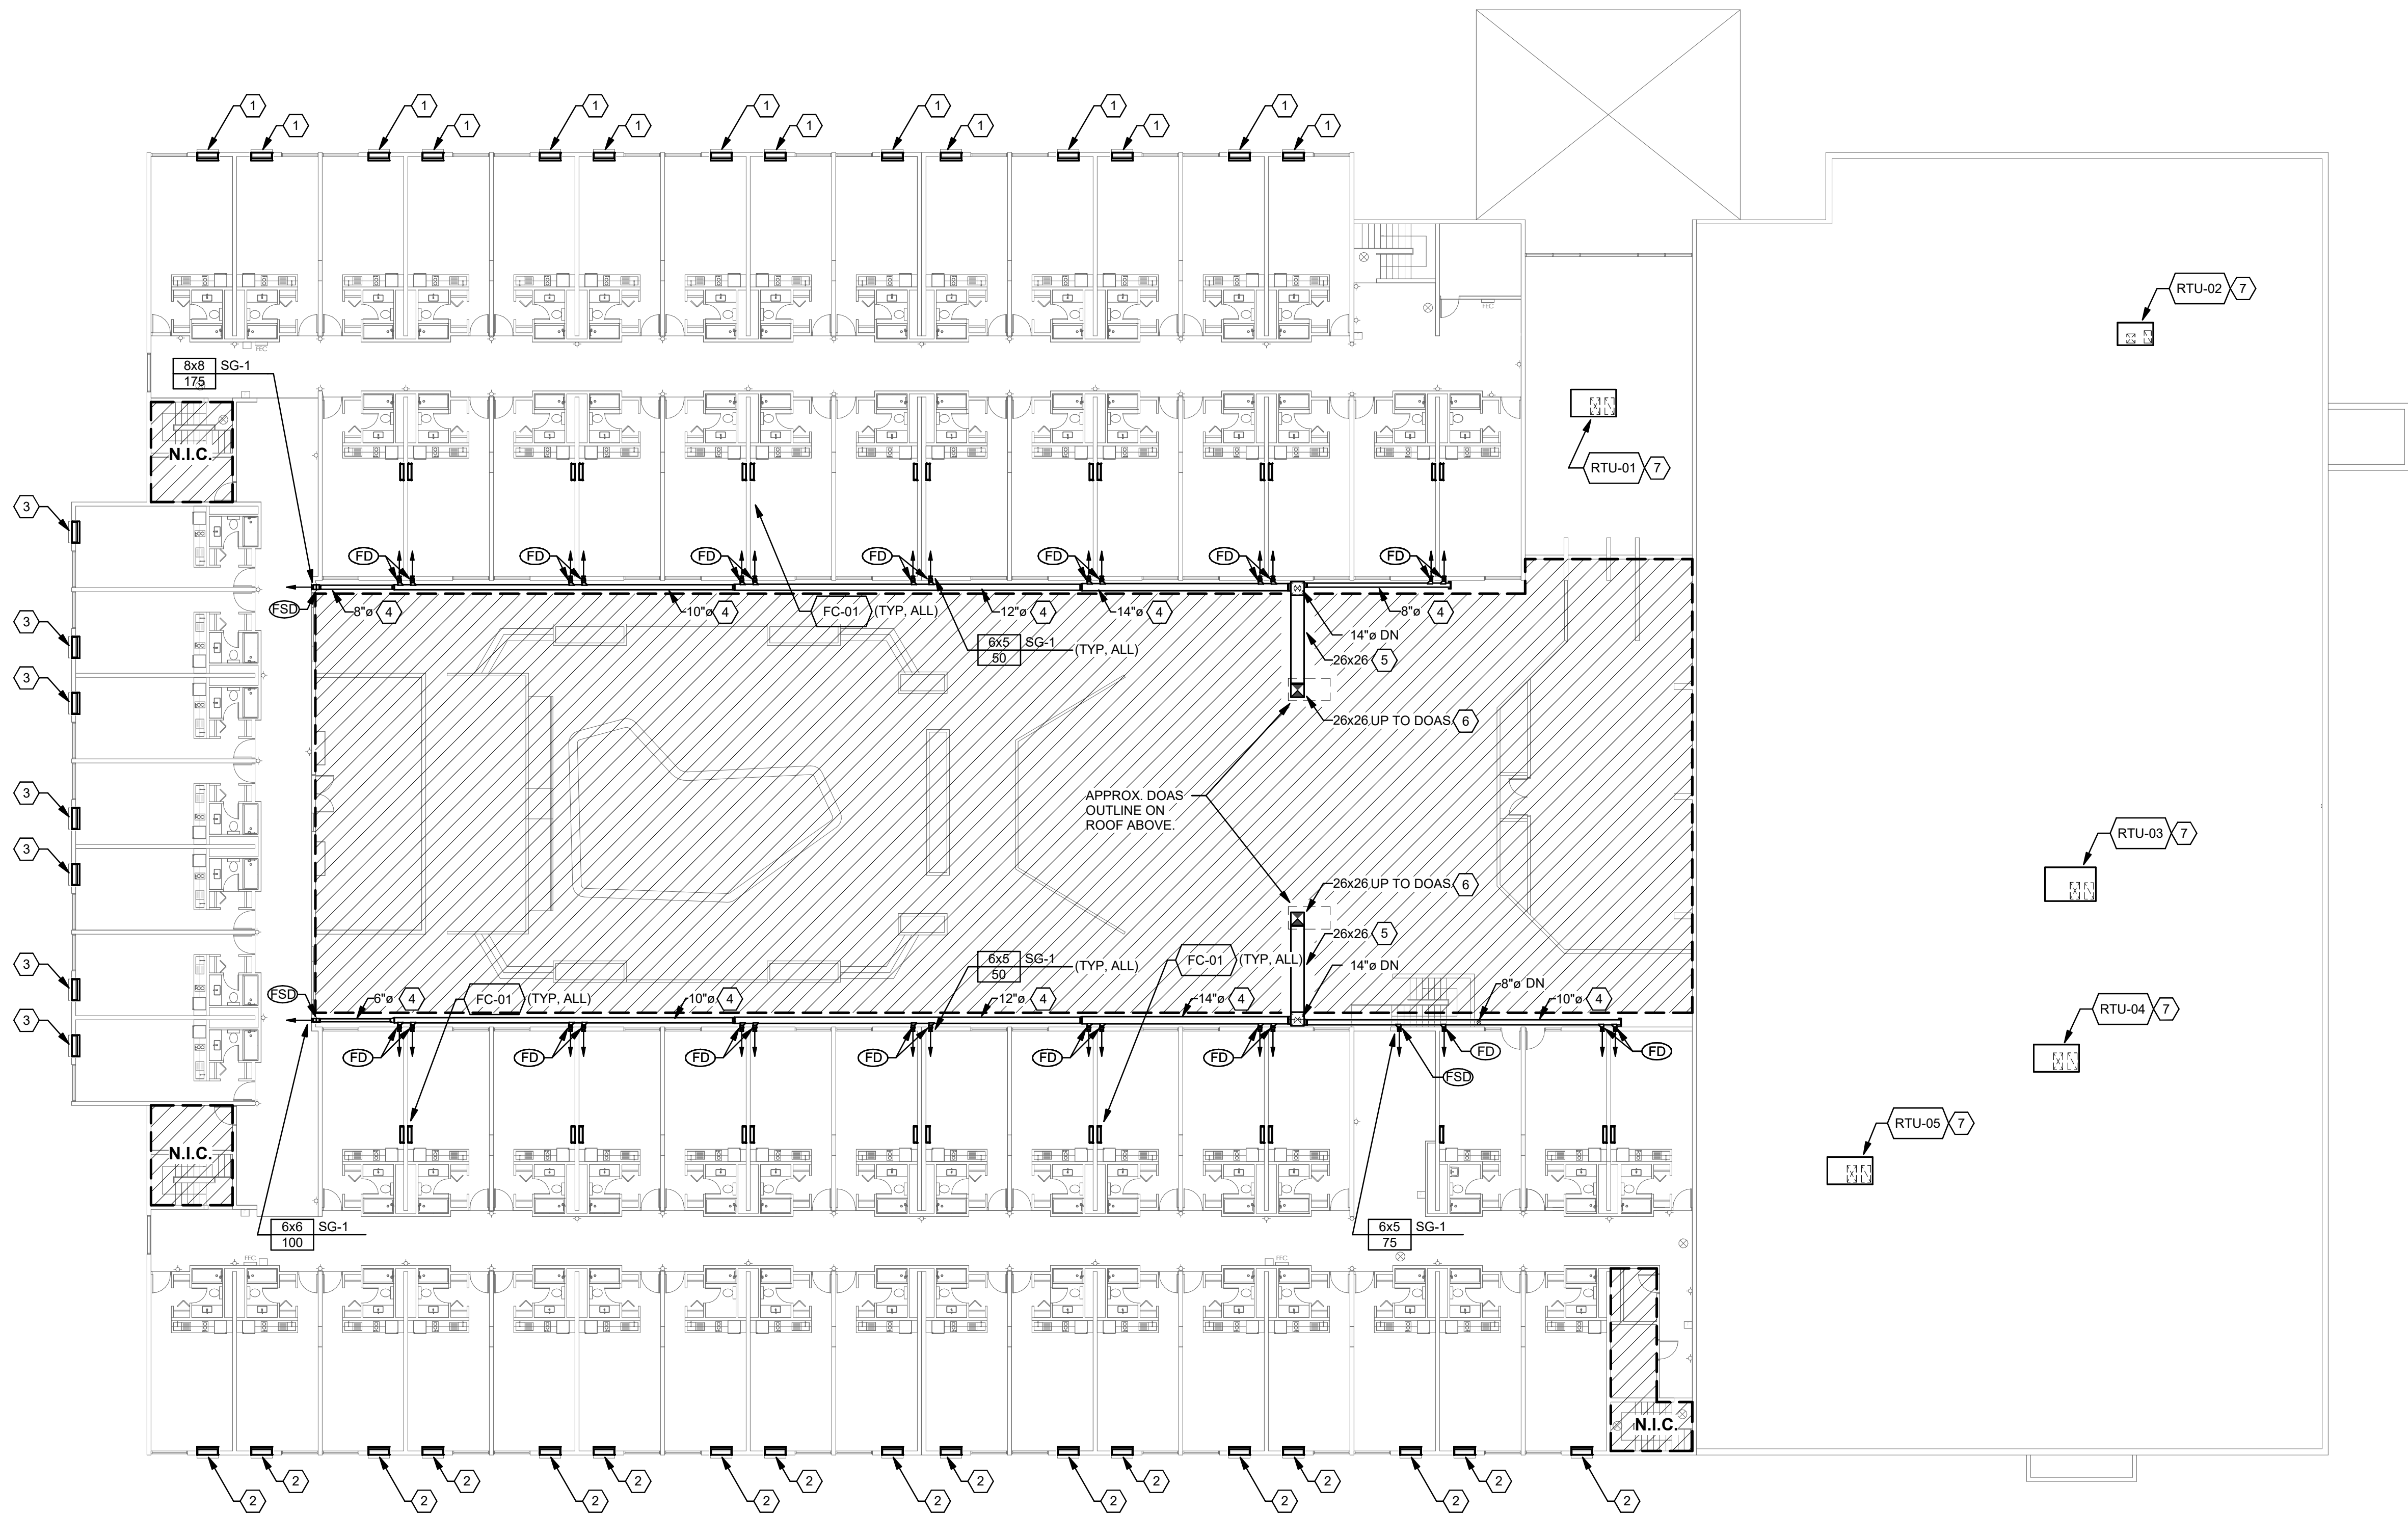


GENERAL SHEET NOTES

A. VERIFY LOCATIONS, DIMENSIONS, ELEVATIONS, ETC. OF EXISTING CONDITIONS AND UTILITIES. CONDITIONS SHOWN ON THE PLANS RELATIVE TO THE WORK TO BE PERFORMED ARE BASED ON THE BEST INFORMATION AVAILABLE BUT ARE SUBJECT TO VERIFICATION. CORRECT DEFICIENCIES CAUSED BY FAILURE TO PERFORM SUCH VERIFICATIONS AT NO EXPENSE TO OWNER. IMMEDIATELY NOTIFY ARCHITECT OF CONDITION IN CONFLICT WITH THE PLANS.

SHEET KEYNOTES

1. PROVIDE PTHP-01 FOR NORTH FACING PERIMETER APARTMENTS. REFER TO DETAIL 1M7.1.
2. PROVIDE PTHP-02 FOR SOUTH FACING PERIMETER APARTMENTS. REFER TO DETAIL 1M7.1.
3. PROVIDE PTHP-03 FOR WEST FACING PERIMETER APARTMENTS. REFER TO DETAIL 1M7.1.
4. INSTALL BOTTOM OF DUCTWORK ABOVE TOP OF WINDOW GLAZING SO DUCT IS NOT VISIBLE FROM INSIDE OF UNIT.
5. INSTALL DUCT IN BETWEEN STRUCTURAL FRAMING, TIGHT TO UNDERSIDE OF ROOF ABOVE, FOLLOWING ANGLE OF ROOF.
6. COORDINATE FINAL LOCATION OF DOAS ABOVE WITH EXISTING STRUCTURE. LOCATE SO DOAS DISCHARGE IS CENTERED BETWEEN STRUCTURAL MEMBERS. DETERMINE LOAD CAPACITY OF EXISTING STRUCTURE AND PROVIDE ADDITIONAL STRUCTURAL REINFORCEMENT AS REQUIRED TO SUPPORT INSTALL DOAS.
7. LOCATE RTU AT EXISTING ROOF CURB AND OPENING. FIELD VERIFY EXACT EXISTING CURB DIMENSIONS. PROVIDE CURB ADAPTER TO MOUNT NEW RTU ON EXISTING CURB.



1 SECOND FLOOR PLAN - MECHANICAL

0' 8' 16' 32'  
1/16" = 1'-0"

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SHEET TITLE

SECOND FLOOR PLAN -  
MECHANICAL

REVISIONS

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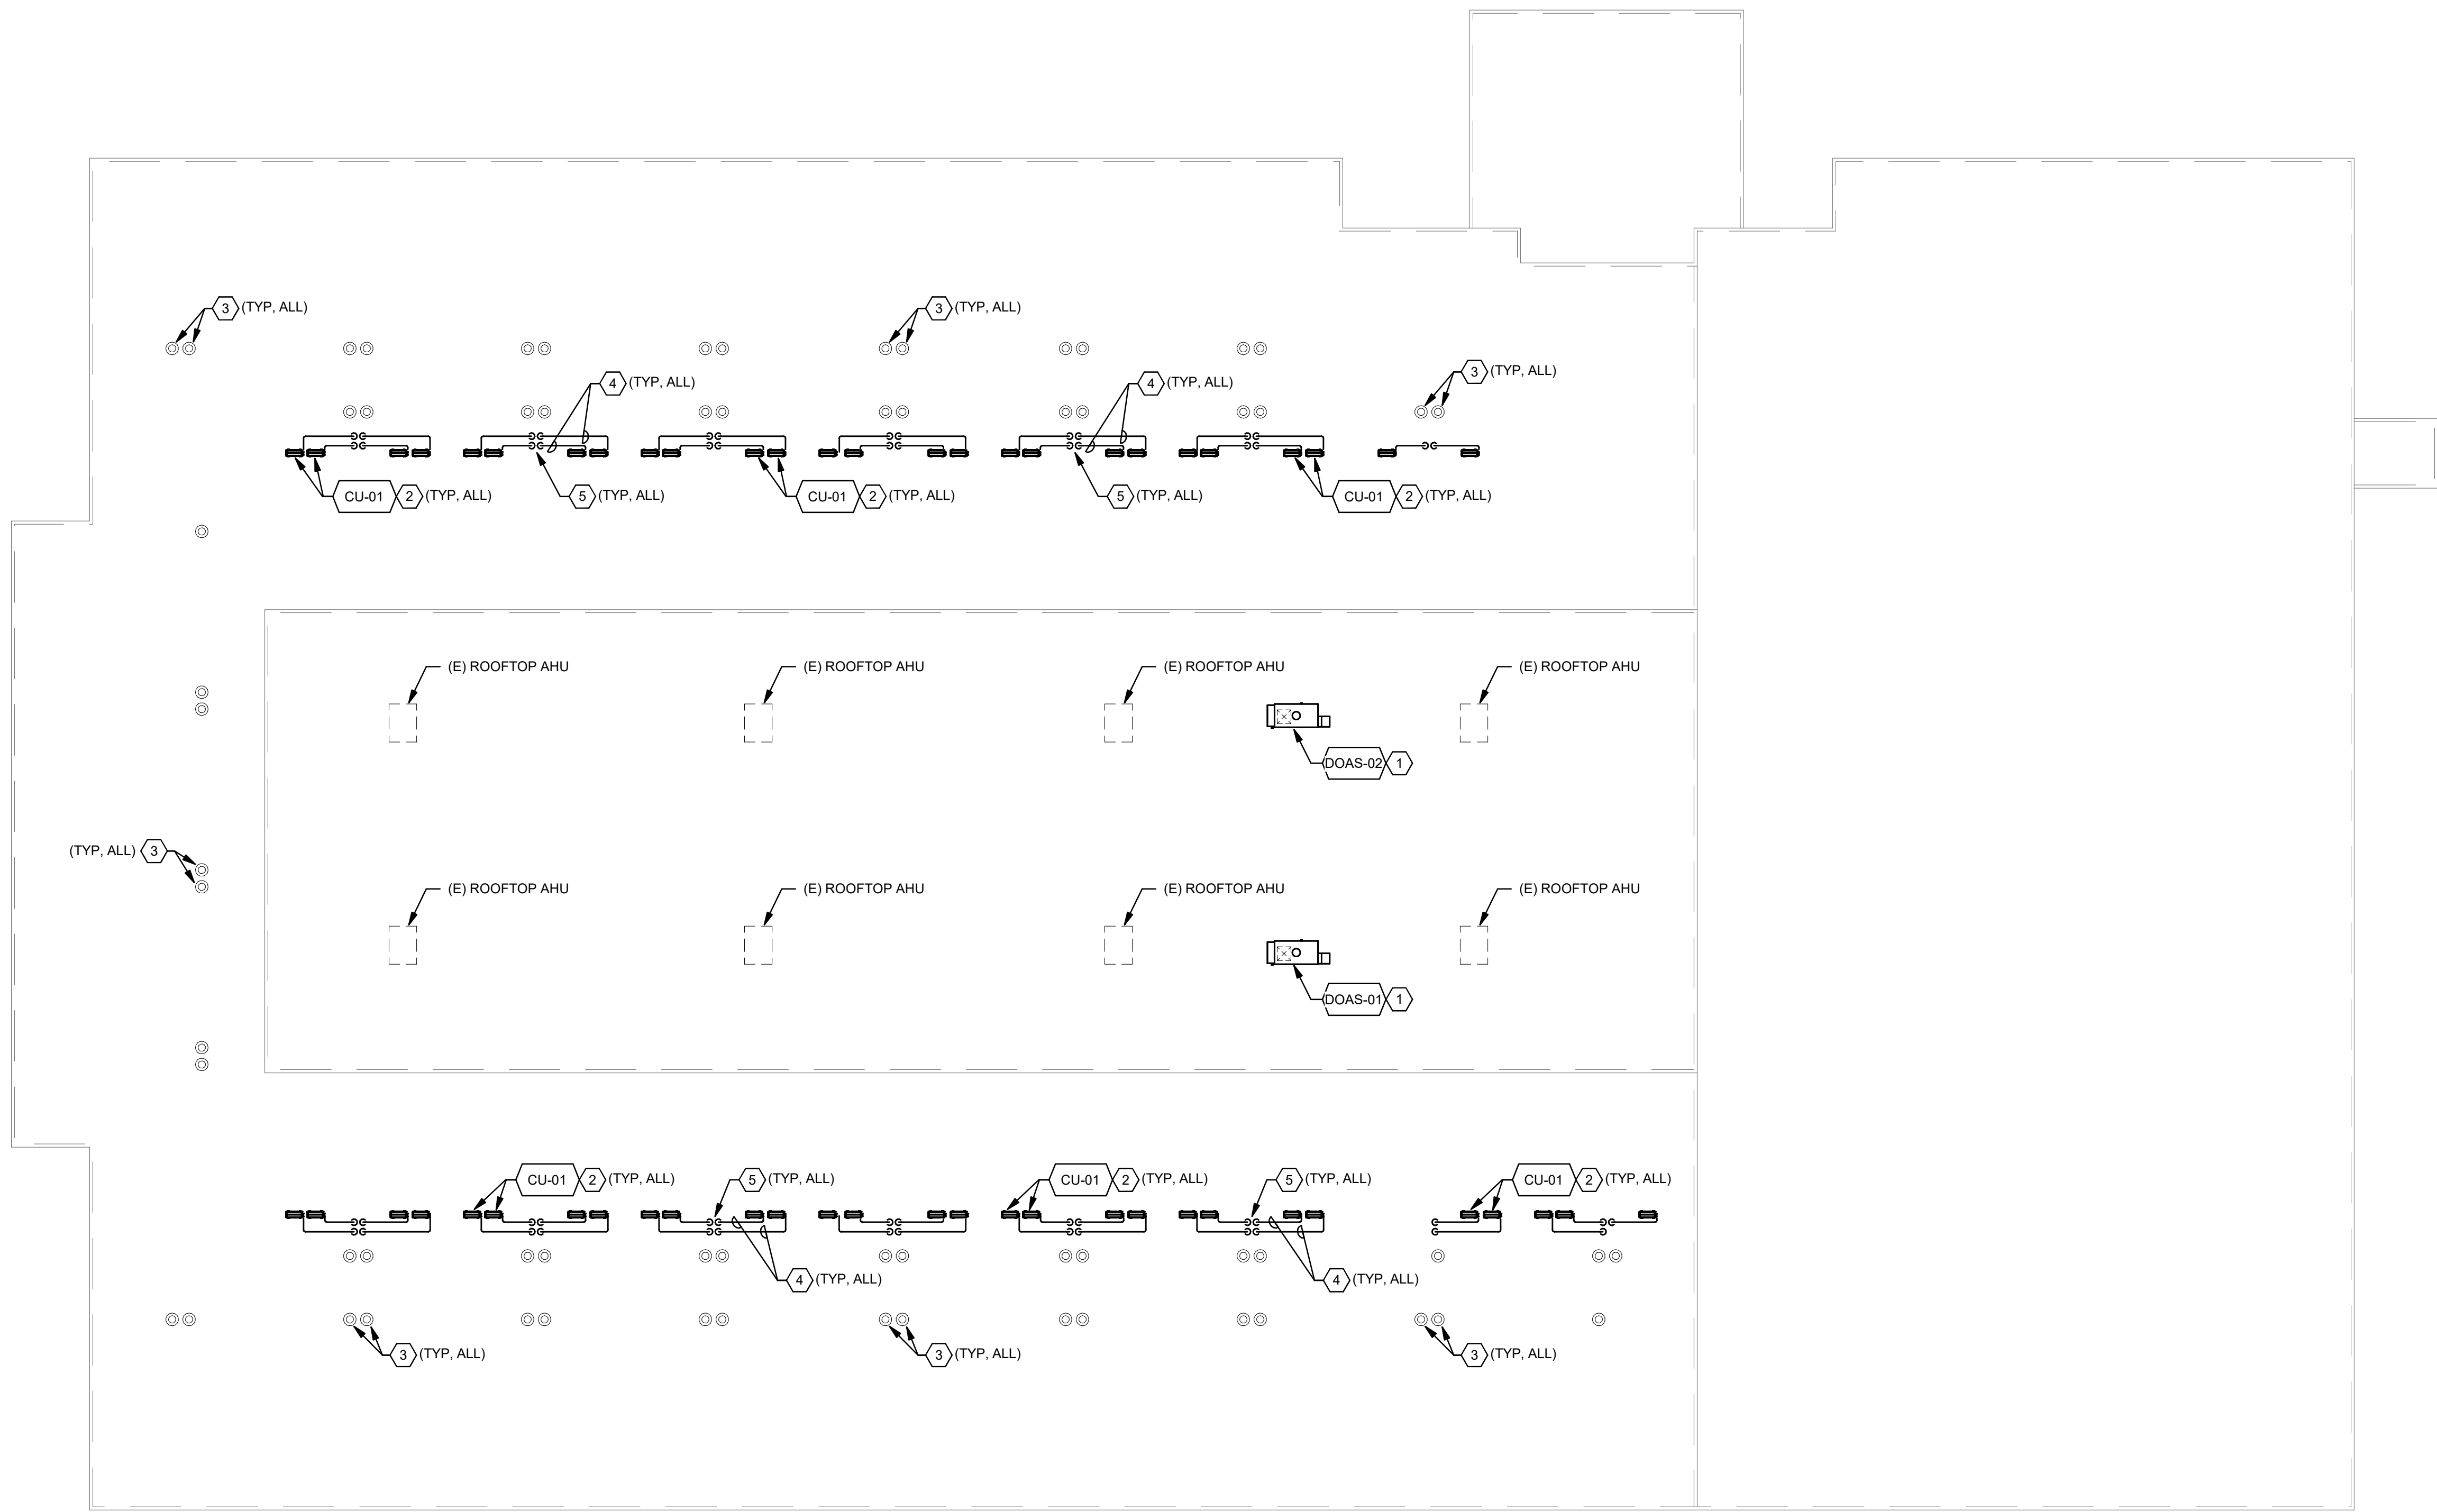
M1.1

**GENERAL SHEET NOTES**

- A. VERIFY LOCATIONS, DIMENSIONS, ELEVATIONS, ETC. OF EXISTING CONDITIONS AND UTILITIES. CONDITIONS SHOWN ON THE PLANS RELATIVE TO THE WORK TO BE PERFORMED ARE BASED ON THE BEST INFORMATION AVAILABLE BUT ARE SUBJECT TO VERIFICATION. CORRECT DEFICIENCIES CAUSED BY FAILURE TO PERFORM SUCH VERIFICATIONS AT NO EXPENSE TO OWNER. IMMEDIATELY NOTIFY ARCHITECT OF CONDITION IN CONFLICT WITH THE PLANS.

**SHEET KEYNOTES**

1. ALIGN DOAS WITH EXISTING TO REMAIN ROOFTOP AHUS. COORDINATE FINAL LOCATION OF DOAS WITH EXISTING STRUCTURE BELOW. LOCATE SO DOAS DISCHARGE IS CENTERED BETWEEN STRUCTURAL MEMBERS. DETERMINE LOAD CAPACITY OF EXISTING STRUCTURE AND PROVIDE ADDITIONAL STRUCTURAL REINFORCEMENT AS REQUIRED TO SUPPORT DOAS INSTALLATION.
2. DEMOLISH EXISTING CURB SUPPORTING PREVIOUS CONDENSING UNIT COMPLETE. PROVIDE AND INSTALL CURBS FOR NEW CONDENSING UNITS PER DETAIL 2/M7.1.
3. EXISTING POWER ROOF VENTILATOR SERVING UNIT TOILET EXHAUST TO REMAIN. INSPECT, SERVICE, AND REBALANCE EXISTING EQUIPMENT AS REQUIRED FOR PROPER OPERATION AND TO EXHAUST 60 CFM FROM EACH TOILET ROOM.
4. ROUTE RS, RL, COMMUNICATIONS, AND POWER PIPING/CONDUIT FROM CU TO ROOF JACK PENETRATION. SUPPORT ALL PIPING PER DETAIL 5/M7.1. PROVIDE INSULATION AND ALUMINUM JACKETING ON ALL REFRIGERANT PIPING EXPOSED TO WEATHER.
5. COORDINATE ROOF PENETRATION LOCATIONS TO ALIGN WITH CHASE BELOW. PROVIDE ROOF JACK FOR WEATHERPROOFING PER DETAIL 6/M7.1 AT ALL ROOF PENETRATION LOCATIONS.



**1 ROOF PLAN - MECHANICAL**

0' 8' 16' 32'  
1/16" = 1'-0"

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SHEET TITLE

ROOF PLAN -  
MECHANICAL

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SHEET NUMBER

M1.2

GENERAL SHEET NOTES

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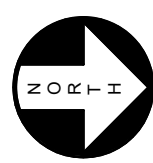
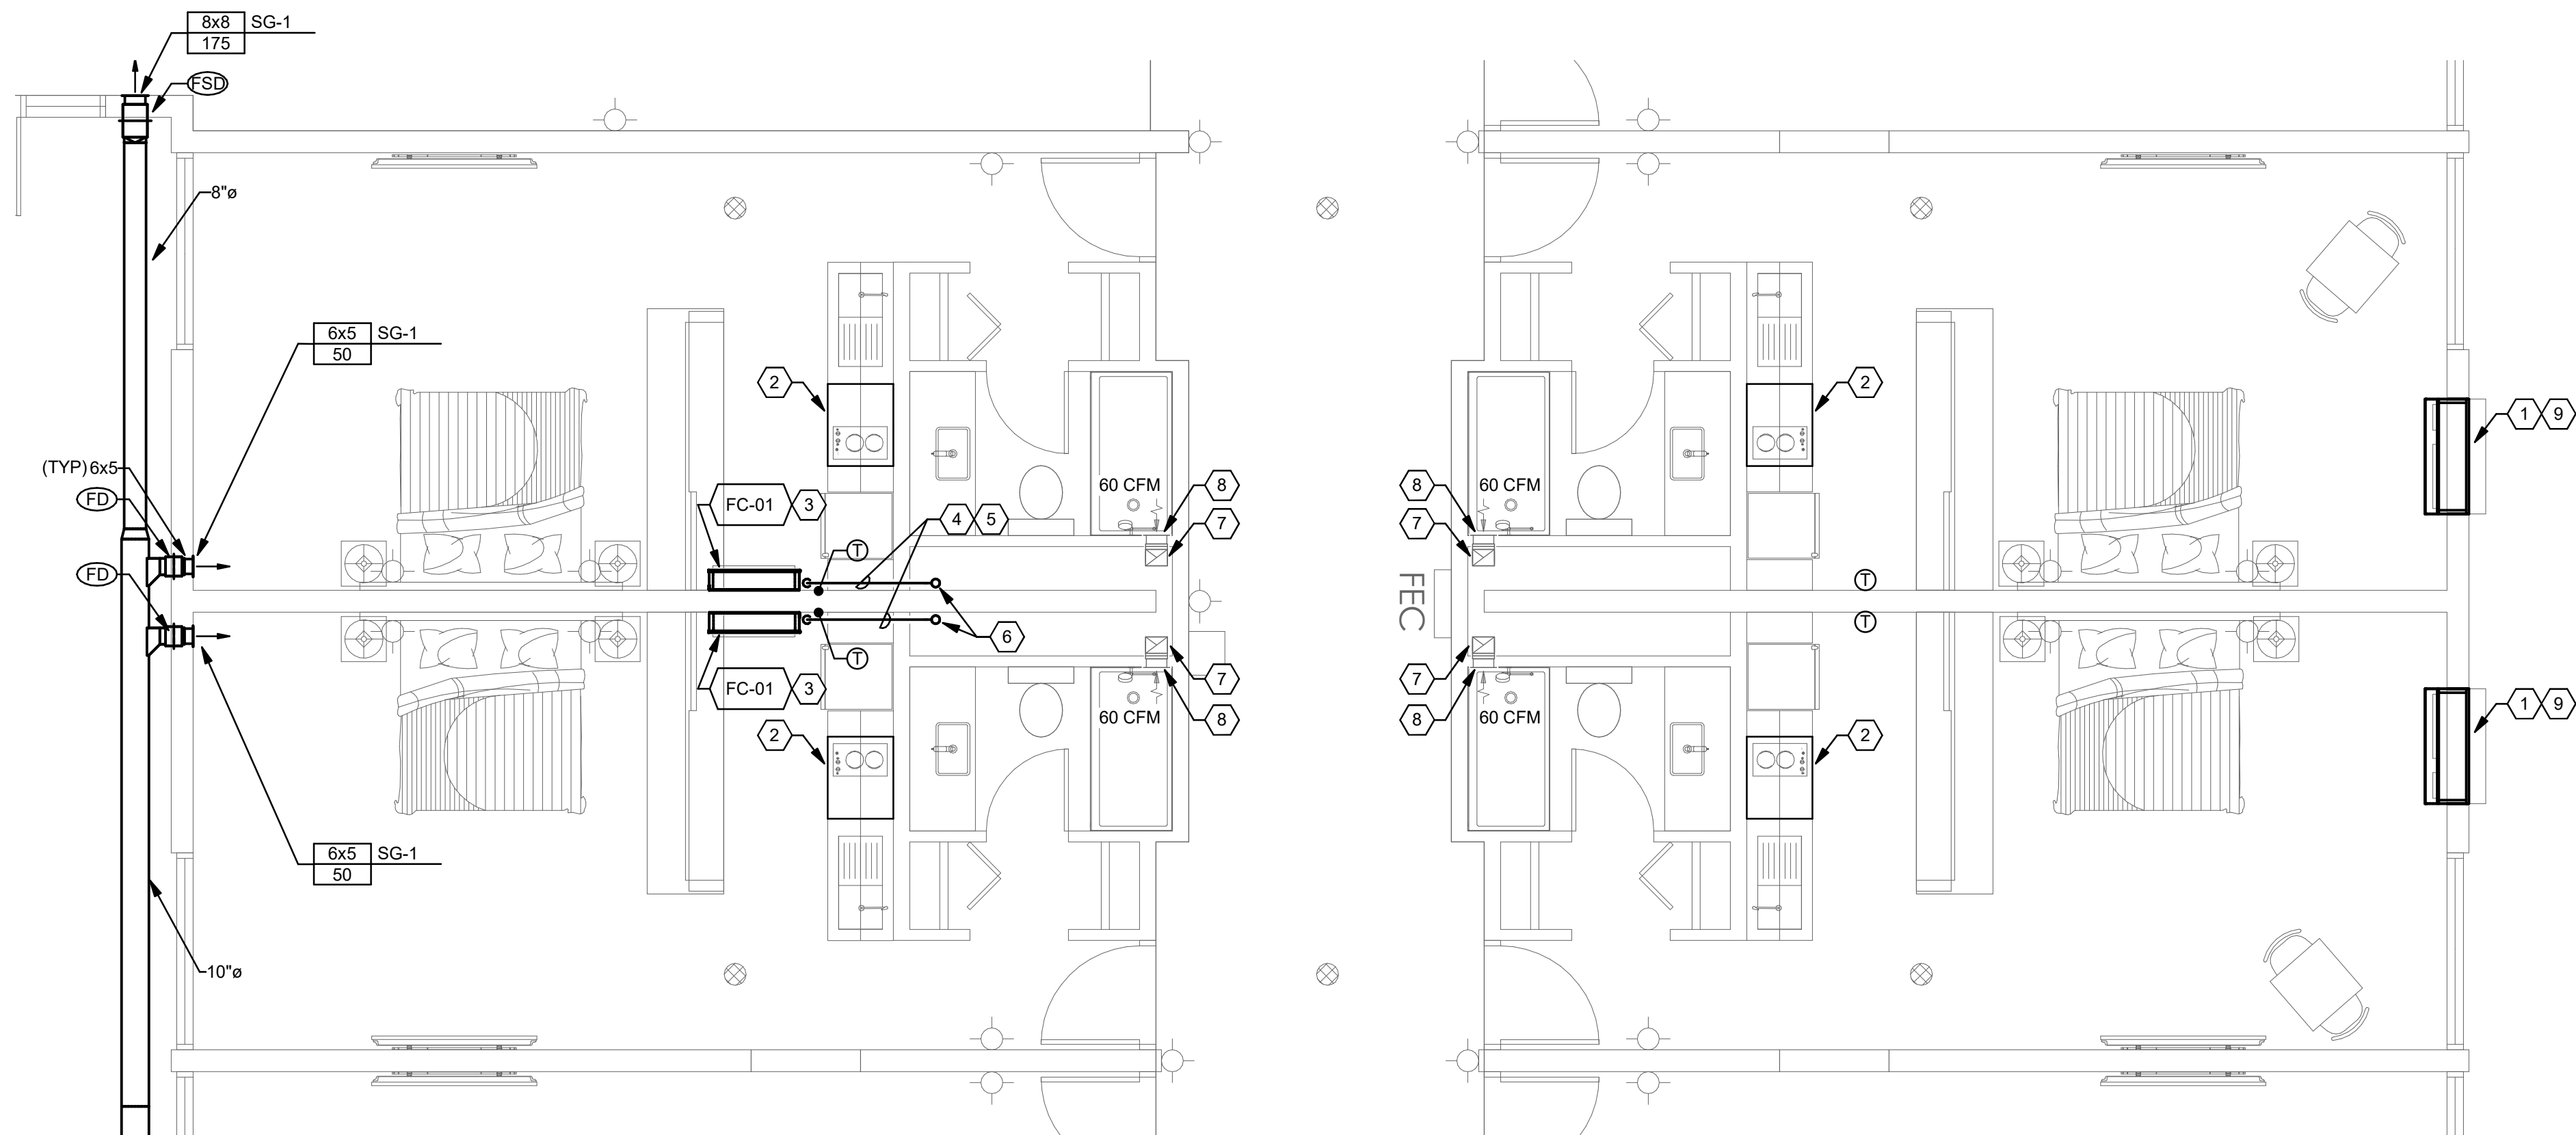
INTERFACE  
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SHEET KEYNOTES

1. PROVIDE PTHP-01 FOR NORTH FACING PERIMETER APARTMENTS, PTHP-02 FOR SOUTH FACING PERIMETER APARTMENTS, AND PTHP-03 FOR WEST FACING PERIMETER APARTMENTS. REFER TO OVERALL FLOOR PLANS AND TO DETAIL 1/M7.1.
2. MICROWAVE LOCATED ABOVE COOKTOP WITH INTEGRAL VENT, LISTED FOR RECIRCULATION, PROVIDED BY OTHERS. REFER TO ARCHITECTURAL.
3. PROVIDE WALL MOUNTED FAN COIL UNIT FOR ALL INTERIOR UNITS. INSTALL HIGH ON WALL, MAINTAINING ALL MANUFACTURER RECOMMENDED CLEARANCES FOR AIRFLOW AND MAINTENANCE.
4. ROUTE RS, RL, COMMUNICATIONS, POWER, AND PUMPED CONDENSATE PIPING/CONDUIT FROM FC TO CHASE, CONSOLIDATED IN SINGLE CONDUIT, EXPOSED, TIGHT ALONG WALL AND TO UNDERSIDE OF STRUCTURE.
5. ROUTE PUMPED CONDENSATE FROM FC TO NEAREST DRAIN OR APPROVED SINK TAILPIECE. COORDINATE WITH PLUMBING CONTRACTOR.
6. PIPING/CONDUIT UP TO ROOF. COORDINATE FINAL LOCATION WITH EXISTING CHASE CONSTRAINTS AND ROOF JACK LOCATIONS ABOVE.
7. EXISTING TO REMAIN EXHAUST DUCT RISER UP TO POWERED ROOF VENTILATOR ON ROOF.
8. EXISTING TO REMAIN EXHAUST GRILLE FOR TOILET EXHAUST. REBALANCE TO ORIGINAL DESIGN AIRFLOW, 60 CFM.
9. UNIT OUTSIDE VENTILATION AIR PROVIDED BY CONTINUOUSLY OPERATING VENT KIT, INTEGRAL TO PTHP.



1 FLOOR PLAN TYPICAL UNITS - MECHANICAL

0' 2' 4' 6'  
1/4" = 1'-0"

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SHEET TITLE

ENLARGED UNIT PLANS  
- MECHANICAL

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M4.0

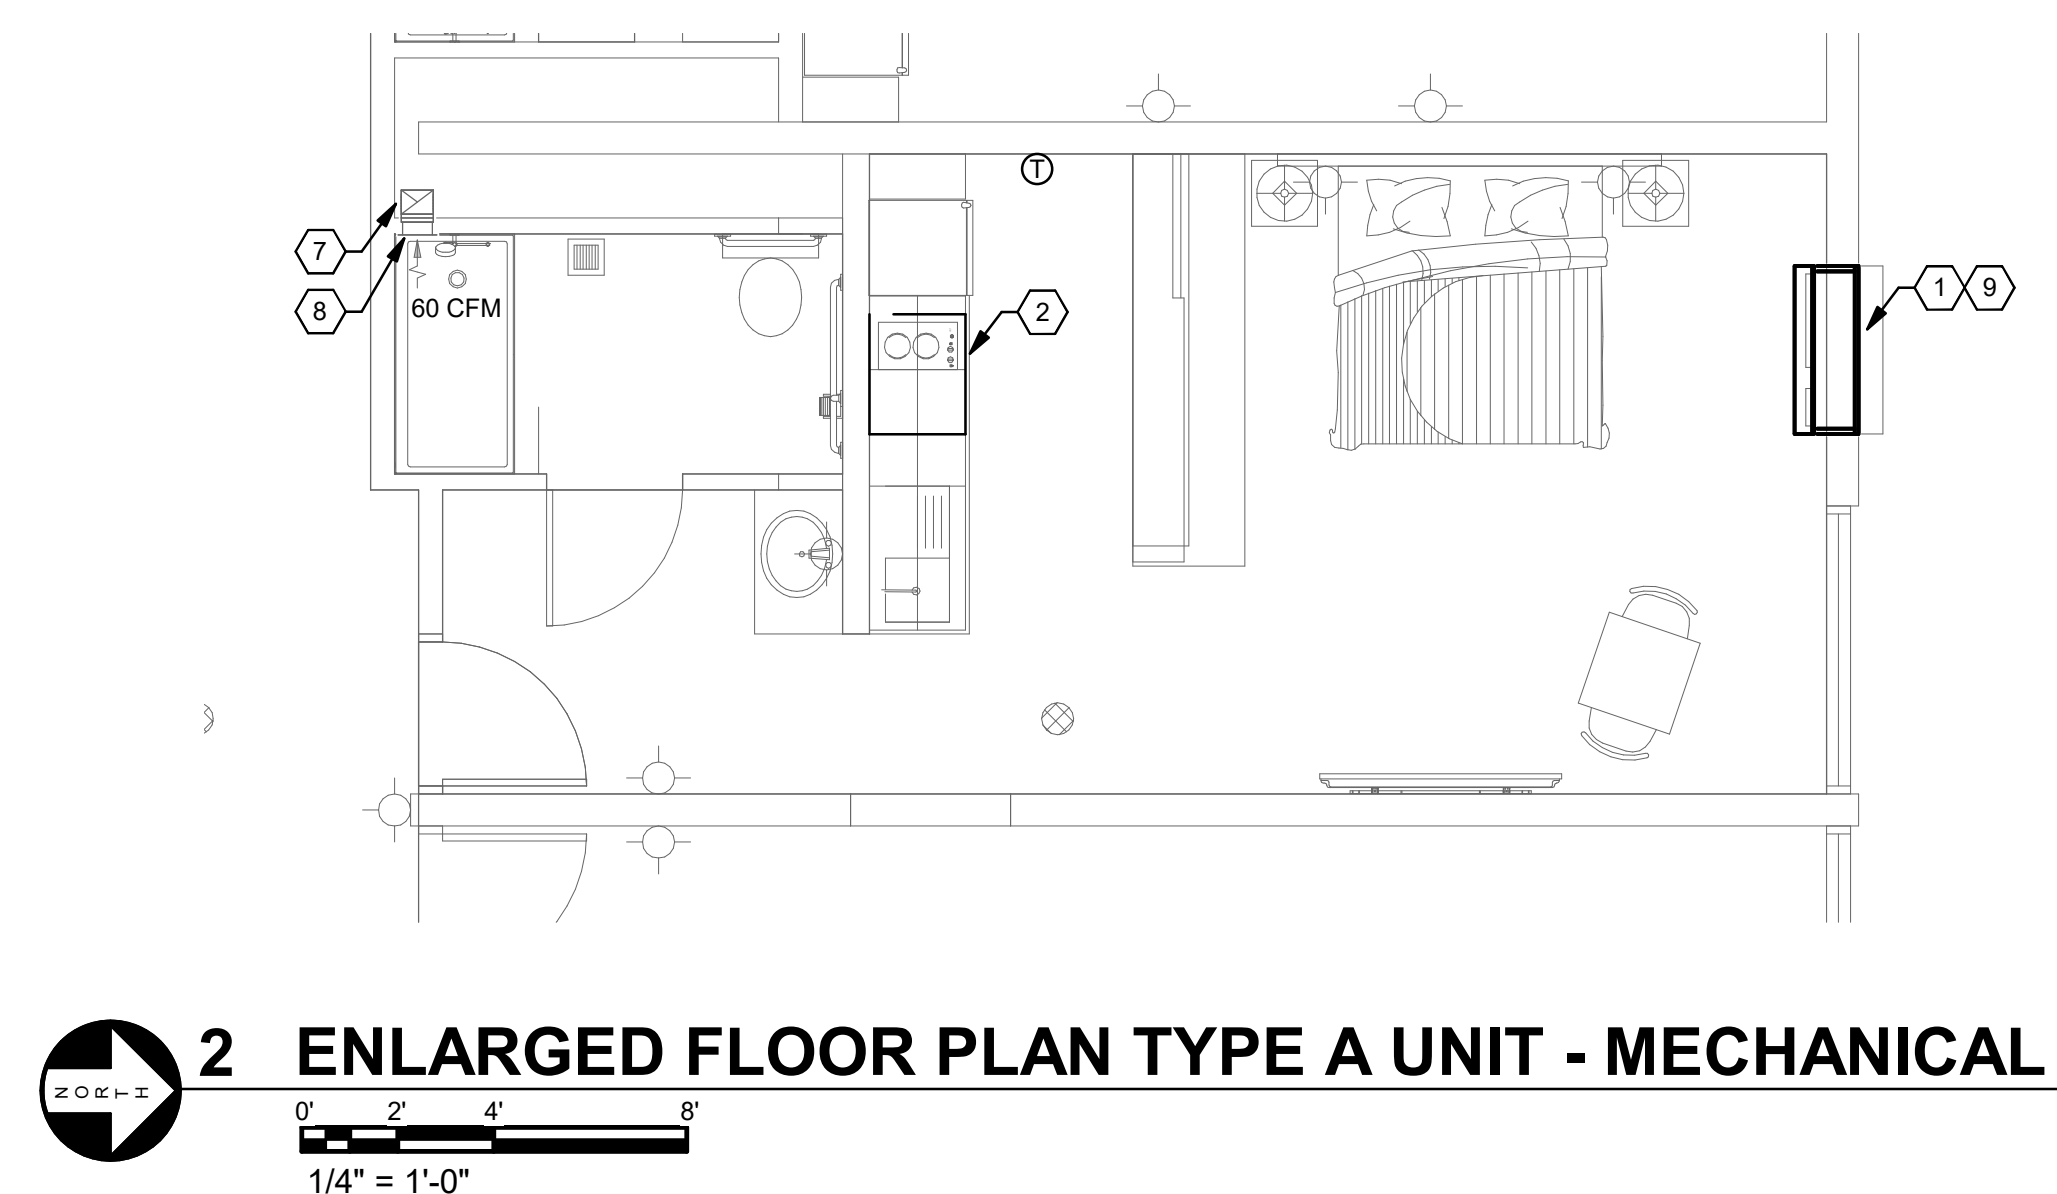
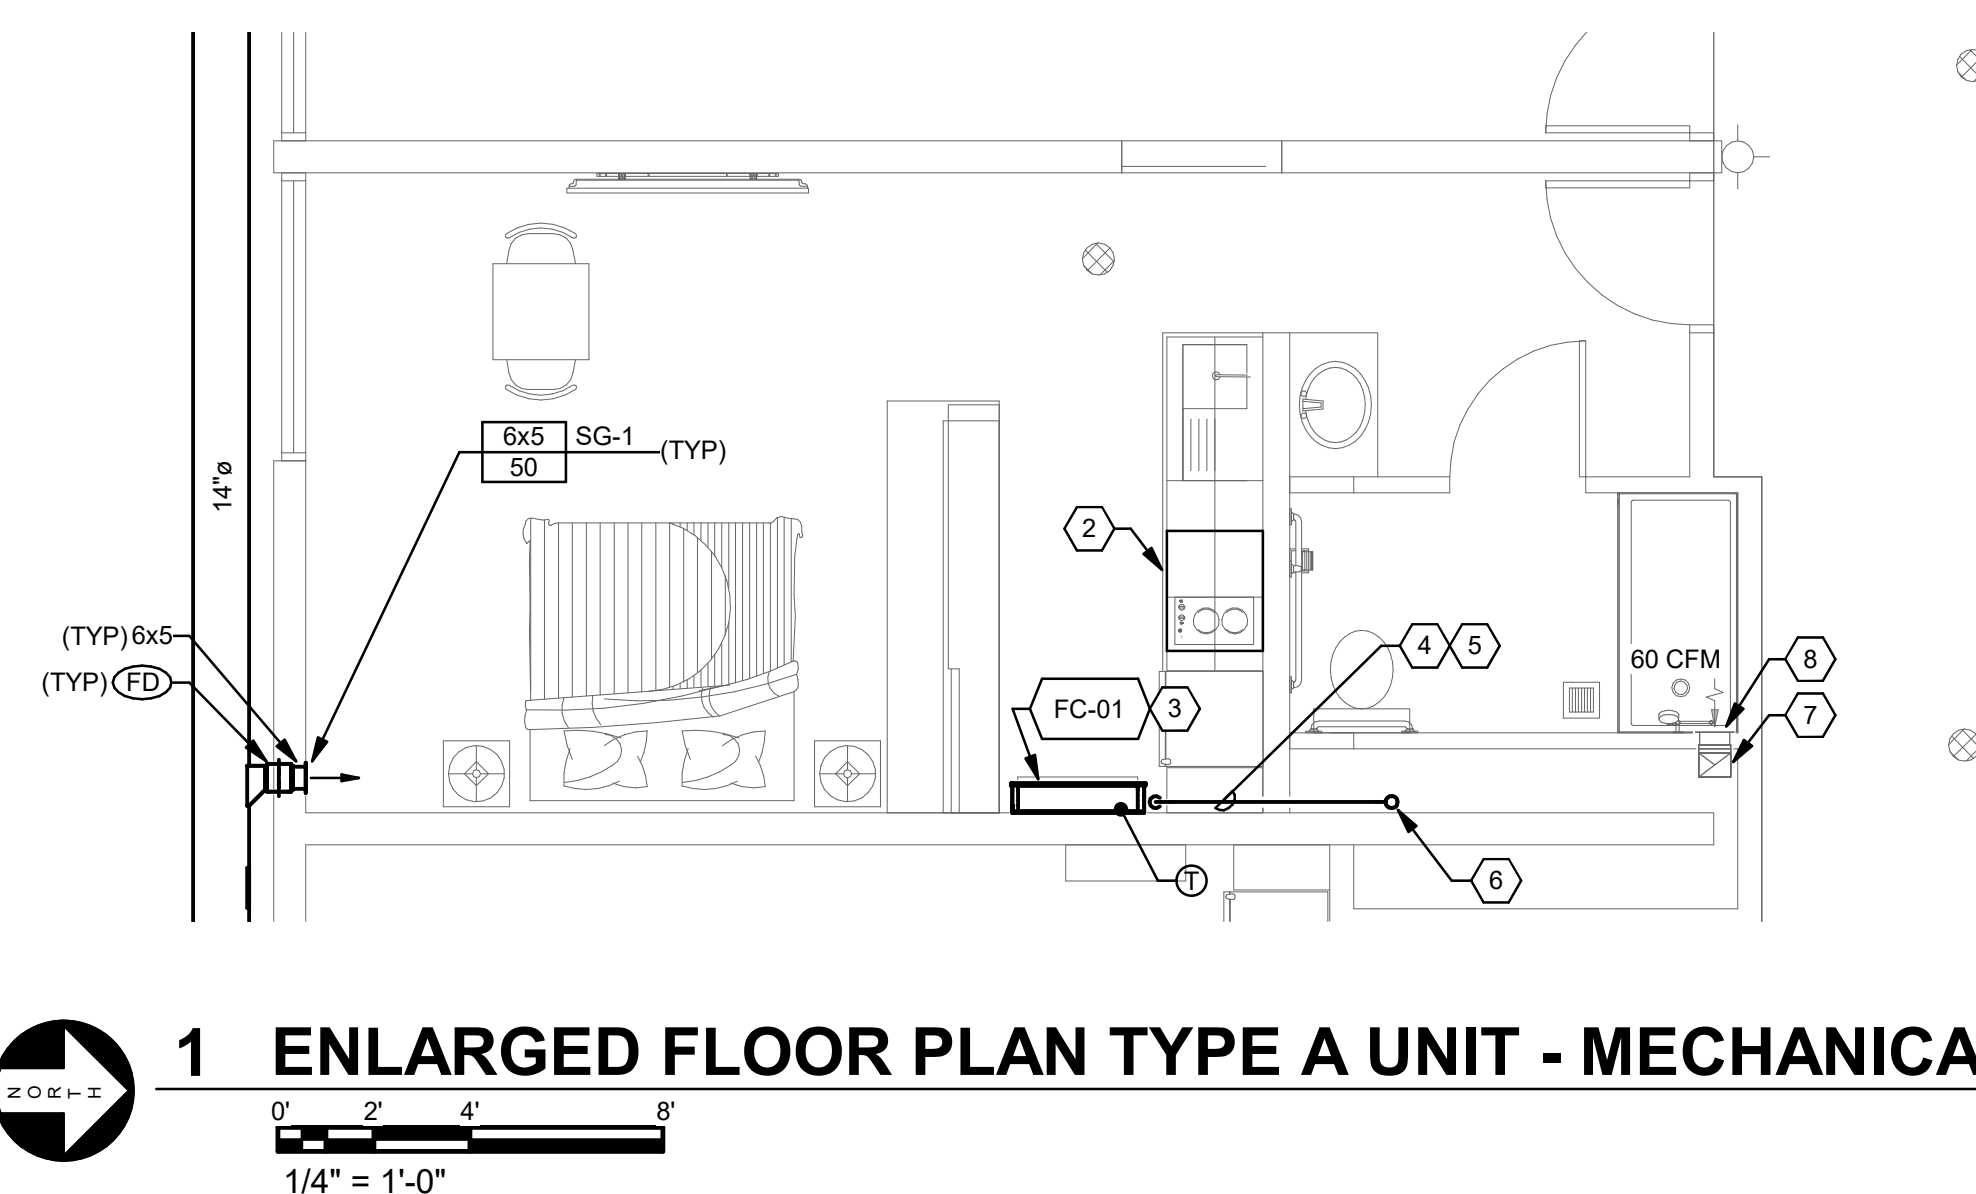


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A. VERIFY LOCATIONS, DIMENSIONS, ELEVATIONS, ETC. OF EXISTING CONDITIONS AND UTILITIES. CONDITIONS SHOWN ON THE PLANS RELATIVE TO THE WORK TO BE PERFORMED ARE BASED ON THE BEST INFORMATION AVAILABLE BUT ARE SUBJECT TO VERIFICATION. CORRECT DEFICIENCIES CAUSED BY FAILURE TO PERFORM SUCH VERIFICATIONS AT NO EXPENSE TO OWNER. IMMEDIATELY NOTIFY ARCHITECT OF CONDITION IN CONFLICT WITH THE PLANS.

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2. RECIRCULATION EXHAUST HOOD LOCATED ABOVE COOKTOP, WITH REMOTE OPERATION MOUNTED IN ACCESSIBLE LOCATION, LISTED FOR RECIRCULATION, PROVIDED BY OTHERS. REFER TO ARCHITECTURAL.
3. PROVIDE WALL MOUNTED FAN COIL UNIT FOR ALL INTERIOR UNITS. INSTALL HIGH ON WALL, MAINTAINING ALL MANUFACTURER'S RECOMMENDED CLEARANCES FOR AIRFLOW AND MAINTENANCE.
4. ROUTE RS, RL, COMMUNICATIONS, POWER, AND PUMPED CONDENSATE PIPING/CONDUP FROM FC TO CHACE, CONSOLIDATED IN SINGLE CONDUP, EXPOSED, TIGHT AGAIN WALL AND TO INSIDE OF STRUCTURE.
5. ROUTE PUMPED CONDENSATE FROM FC TO NEAREST DRAIN OR APPROVED SINK TAILPIPE.
6. PIPING/CONDUP UP TO ROOF, COORDINATE FINAL LOCATION WITH EXISTING CHACE CONSTRAINTS AND ROOF JACK LOCATIONS ABOVE.
7. EXISTING TO REMAIN EXHAUST DUCT RISER UP TO POWERED ROOF VENTILATOR ON ROOF.
8. EXISTING TO REMAIN EXHAUST GRILLE FOR TOILET EXHAUST. REBALANCE TO ORIGINAL DESIGN AIRFLOW, 60 CFM.
9. UNIT OUTSIDE VENTILATION AIR PROVIDED BY CONTINUOUSLY OPERATING VENT KIT, INTEGRAL TO PTHP.



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SHEET TITLE  
ENLARGED ACCESSIBLE  
UNIT PLANS -  
MECHANICAL

[illegible]

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## M4.1

## 8 CONDENSATE TRAP

NO SCALE

## 5 ROOFTOP REFRIGERATION PIPING SUPPORT

NO SCALE

**NOTE:**  
1. PAINT ALL EXPOSED SHEET METAL PARTS WITH WEATHER RESISTANT PAINT  
COORDINATE WITH ARCHITECTURAL FOR FINAL COLOR SELECTION.

## 6 ROOF JACK FOR PIPES THRU ROOF

NO SCALE

## 7 DRYER VENT DETAIL

NO SCALE

**NOTES:**  
1. REFER TO ARCHITECTURAL FOR ADDITIONAL WATERPROOFING REQUIREMENTS.  
2. REFER TO ARCHITECTURAL FOR UNIT ELEVATIONS.

## 1 THRU THE WALL HEAT PUMP

NO SCALE

## 2 CONDENSING UNIT - ROOF-MOUNTED

NO SCALE

### 3 ROOF TERMINATION - RAIN CAP

NO SCALE

## 4 GENERAL EQMT CURB

NO SCALE



**INTERFACE**  
ENGINEERING

**PROJECT** 2022-1135  
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**HAVEN LIVING**  
33009 W HISTORIC HWY 66  
GALLUP, NM 87301

SHEET TITLE  
DETAILS - MECHANICAL

[illegible]

DRAWN BY PHH

CHECKED BY JMM

JOB NO. 2022-1372

DATE 03/31/2023

SHEET NUMBER

## M7.1